

LOCATION PLAN EXISTING (WITH TREE RPA)

SCALE 1:1250



SITE PLAN SHOWS AREA (AT A SCALE OF 1:1250) THE REPRESENTATION OF A ROAD, TRACK OR PATH IS NO EVIDENCE OF A RIGHT OF WAY. THE REPRESENTATION OF FEATURES AS LINES IS NO EVIDENCE OF A PROPERTY BOUNDARY. MAP PRODUCED FROM THE ORDNANCE SURVEY NATIONAL GEOGRAPHIC DATA BASE AND INCORPORATING SURVEYED REVISION AVAILABLE. REPRODUCTION IN WHOLE OR PART IS PROHIBITED WITHOUT THE PRIOR PERMISSION OF ORDNANCE SURVEY. © CROWN COPYRIGHT 2015. Supplied by BUYAPLAN.CO.UK

LAND AGGUISTION - PLANNING - DEVELOPEMNT CONNECTING THE URBAN GRAIN 36/1 HIGH STREET, PERTH, PERTHSHIRE, SCOTLAND INFO@IUDEV.CO.UK WWW.IUDEV.CO.UK

INTERURBAN ELOPMENTS

PLOT AT MARMION ROAD, F

DATE: DEC 2015

DRAWN BY: JR













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LOCATION PLAN AERIAL PROPOSED

SCALE 1:1250

T AT MARMION ROAD, HAWICK,

PPD

CONNECTING THE U

36/1 HIGH STREET, PERTH, P

INFO@LUDEV.

NTERURBAN

ELOPMENTS


DATE: DEC 2015

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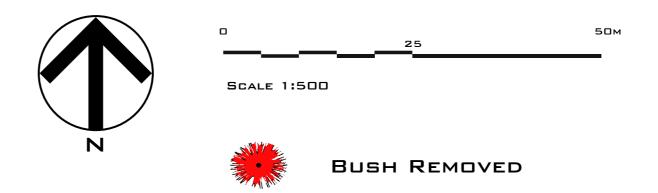
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SITE PLAN SHOWS AREA (AT A SCALE OF 1:500) THE REPRESENTATION OF A ROAD, TRACK OR PATH IS NO EVIDENCE OF A RIGHT OF WAY. THE REPRESENTATION OF FEATURES AS LINES IS NO EVIDENCE OF A PROPERTY BOUNDARY. MAP PRODUCED FROM THE ORDNANCE SURVEY NATIONAL GEOGRAPHIC DATA BASE AND INCORPORATING SURVEYED REVISION AVAILABLE. REPRODUCTION IN WHOLE OR PART IS PROHIBITED WITHOUT THE PRIOR PERMISSION OF ORDNANCE SURVEY. © CROWN COPYRIGHT 2015. Supplied by BUYAPLAN.CO.UK

BLOCK PLAN AERIAL EXISTING

SCALE 1:500

PLOT AT MARMION ROAD,

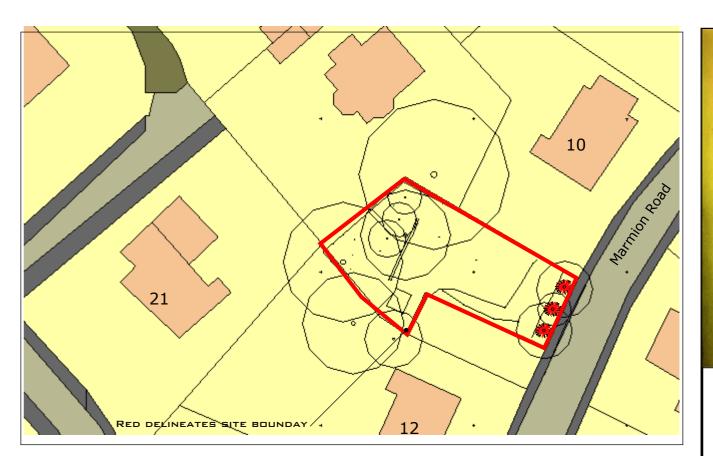INTERURBAN

DEVELOPMENTS


LAND ACQUISTION - PLANNING - DEVELOPEMNT GONNECTING THE URBAN GRAIN 36/1 HIGH STREET, PERTH, PERTHSHIRE, SCOTLA INFO@IUDEV.CO.UK WWW.IUDEV.CO.UK

DATE: DEC 2015

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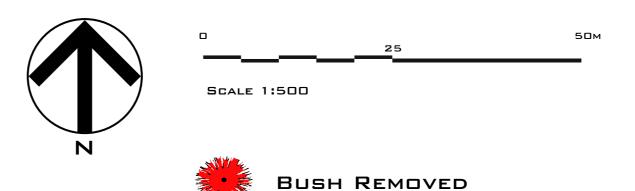




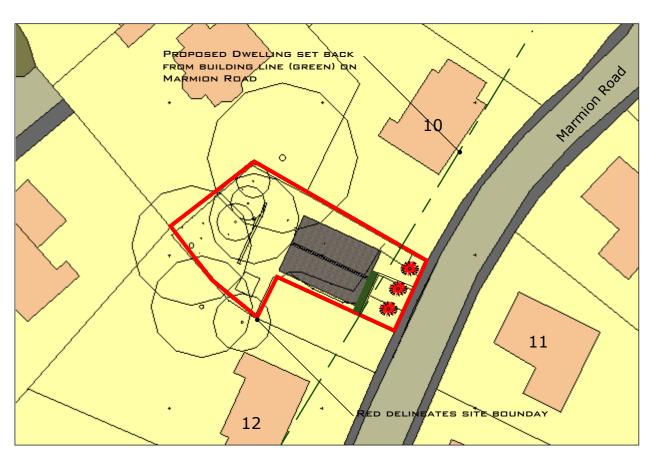

BLOCK PLAN PROPOSED (TREES REMOVED)

SCALE 1:500



SITE PLAN SHOWS AREA (AT A SCALE OF 1:500) THE REPRESENTATION OF A ROAD, TRACK OR PATH IS NO EVIDENCE OF A RIGHT OF WAY. THE REPRESENTATION OF FEATURES AS LINES IS NO EVIDENCE OF A PROPERTY BOUNDARY. MAP PRODUCED FROM THE ORDNANCE SURVEY NATIONAL GEOGRAPHIC DATA BASE AND INCORPORATING SURVEYED REVISION AVAILABLE. REPRODUCTION IN WHOLE OR PART IS PROHIBITED WITHOUT THE PRIOR PERMISSION OF ORDNANCE SURVEY. © CROWN COPYRIGHT 2015. Supplied by BUYAPLAN.CO.UK

BLOCK PLAN AERIAL PROPOSED

SCALE 1:500


PLOT AT MARMION ROAD, HA

INTERURBAN ELOPMENTS

LAND ACQUISTION - PLANNING - DEVELDPEMNT CONNECTING THE URBAN GRAIN 36/1 HIGH STREET, PERTH, PERTHSHIRE, SCOTLAN INFO@IUDEV.CO.UK WWW.IUDEV.CO.UK

DATE: DEC 2015

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20м

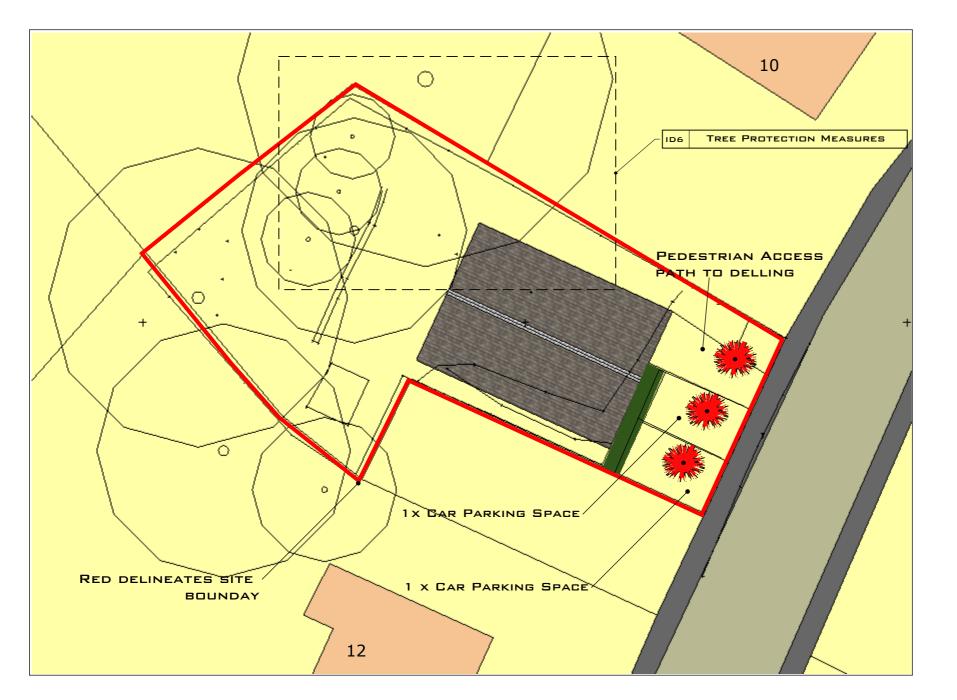

BLOCK PLAN PROPOSED (TREES RPA)

SCALE 1:200

10

SCALE 1:200

INTERURBAN

LAND

DEVELOPMENTS LTD

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PLOT AT MARMION ROAD, HAWICK,


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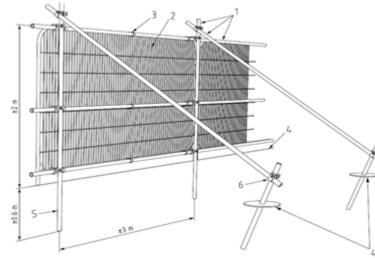
CHECKED BY: JR



1 🗆 м

PROTECT THE ROOT PROTECTION AREA AS DESCRIBED IN BS 5837: 2012. TREES IN RELATION TO CONSTRUCTION, SUCH FENCING MUST BE ERECTED BEFORE ANY MATERIALS OR MACHINERY ARE BROUGHT ON THE SITE AND BEFORE ANY DEMOLITION OR DEVELOPMENT, INCLUDING ERECTION OF SITE HUTS HAS COMMENCED. ONCE ERECTED FENCES SHALL BE REGARDED AS SACROSANCT AND SHOULD NOT BE REMOVED OR ALTERED WITHOUT PRIOR CONSULTATION WITH THE ARBORICULTURALIST OR THE COUNCILS PLANNING AUTHORITY WHERE CONDITIONAL CONTROLIS APPLIED. DUE TO THE PROXIMITY OF INTENSIVE AREAS OF CONSTRUCTION THE FENCE SHOULD BE 2.4M HIGH. NO TEMPORARY VEHICLE ACCESS IS REQUIRED THROUGH THE PROTECTED AREA.


ALL TREES WHICH ARE TO BE RETAINED ON SITE MUST BE PROTECTED BY FENCING TO

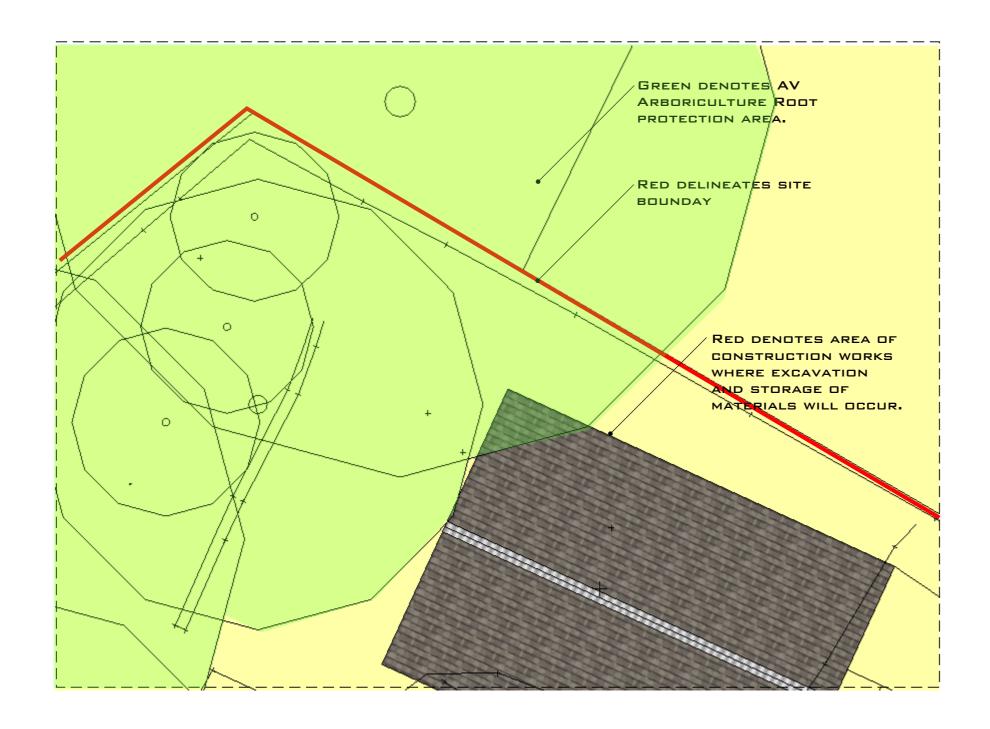


- Standard scaffold poles
- Heavy gauge 2 m tall galvanized tube and welded mesh infill panels
- 3 Panels secured to uprights and cross-members with wire ties
- 5 Uprights driven into the ground until secure (minimum depth 0.6 m)
- 6 Standard scaffold clamps

IN THIS CASE THE MAJORITY OF THE BUILDING IS LOCATED OUTWITH THE ROOT PROTECTION AREA OF THE TREES AS SPECIFIED BY AV ARBORICULTURE TREE SURVEY (SEE SEPERATE SURVEY REPORT).

WHERE CONSTRUCTION IS PROPOSED WITHIN THE RPA, (IN THIS CASE A SMALL INCURSION OF THE BUILDINGS NORTHERN CORNER) A TREE PROTECTION PLAN AND AN ARBORICULTURAL METHOD STATEMENT CAN BE PRODUCED. THIS CAN BE SATISFACYORILY CONTROLED BY THE IMPOSITION OF A PLANNING CONDITION.

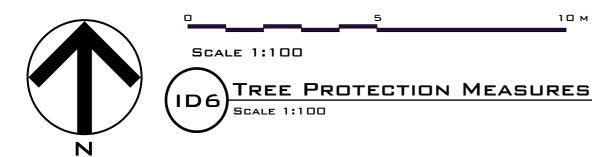

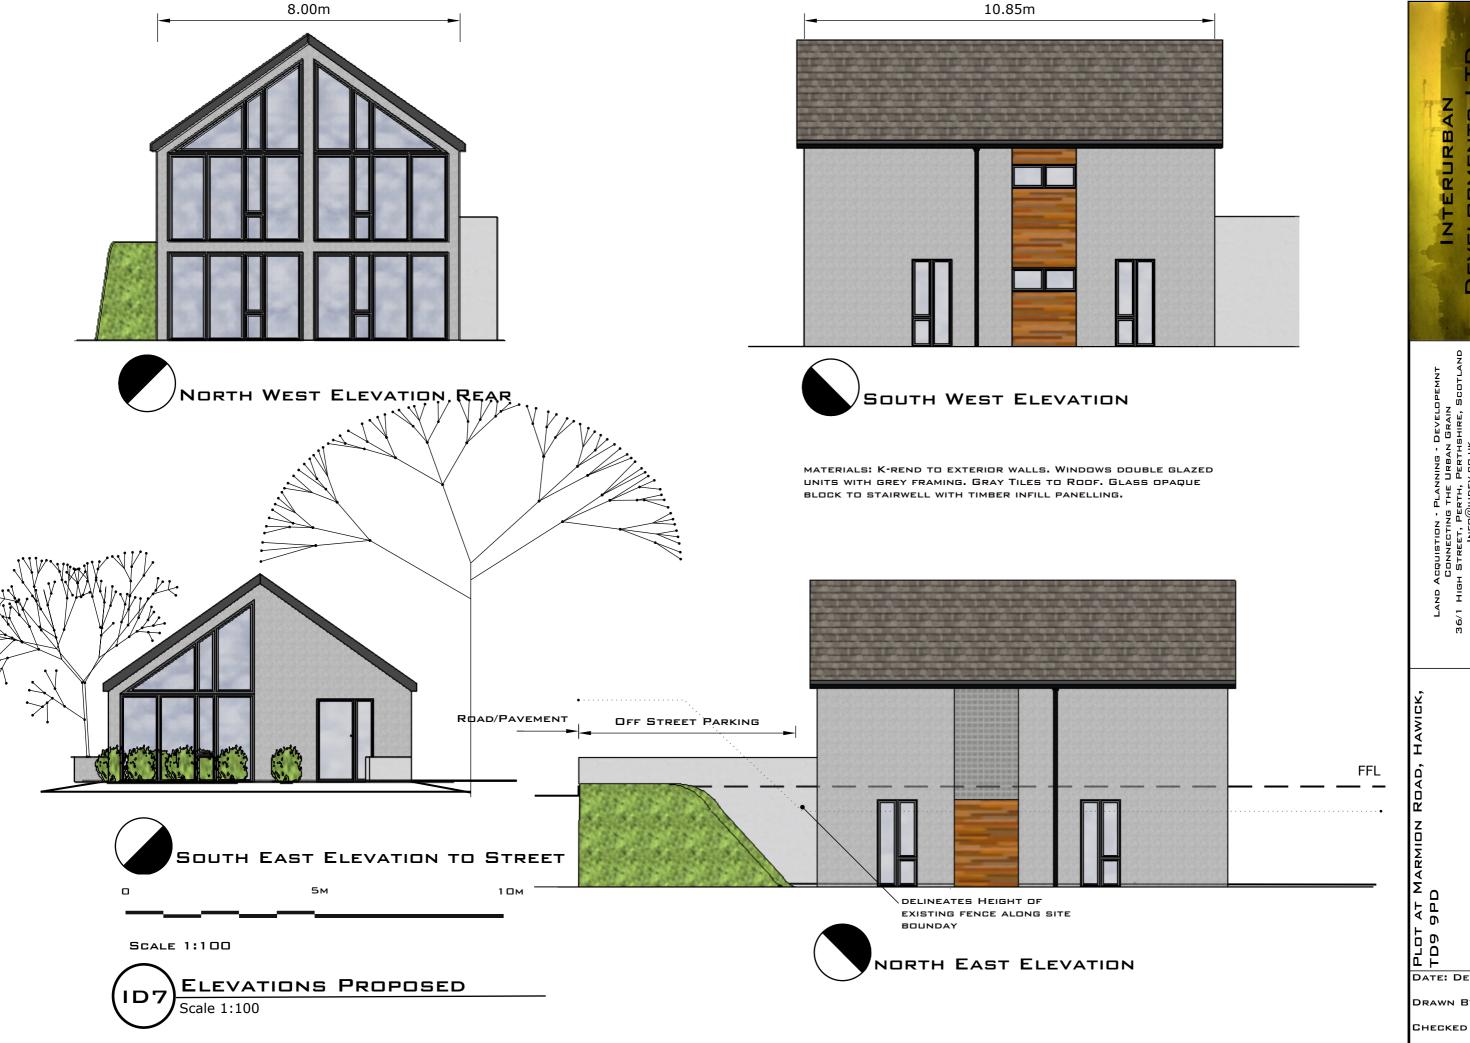

DEVELOPMENTS

LAND ACQUISTION - PLANN CONNECTING THE U 36/1 HIGH STREET, PERTH, P INFO@IUDEV. WWW.IUDEV.G

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 $2.29M \times 1.93M = 4.425QM$ 

W.C

BEDROOM 2  $3.62M \times 4.93M = 17.8SQM$ BEDROOM 3 3.62M  $\times$  3.02M = 10.95QM BEDROOM 4  $3.62M \times 3.02M = 10.95QM$ W.C  $2.29M \times 2.64M = 65QM$ 8.00 m

BEDROOM 1 3.62M  $\times$  4.30M = 15.65QM

BEDROOM 1 BEDROOM 2 10.85 m BEDROOM 3 BEDROOM 4


GROUND

LOWER

1□ м SCALE 1:100

FLOOR PLANS PROPOSED SCALE 1:100

FLOOR GROUND

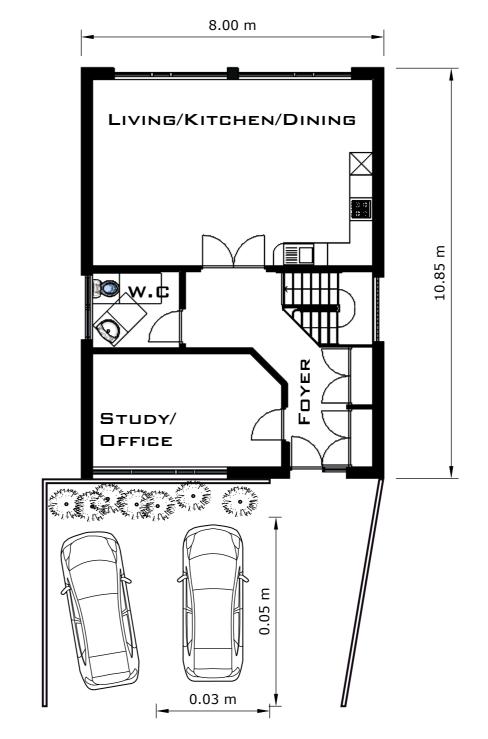

LAND ACQUISTION - PLANN CONNECTING THE U 36/1 HIGH STREET, PERTH, P INFO@IUDEV.

INTERURBAN

DEVELOPMENTS

PLOT TD9

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